

EQUAL, CISPI 310 ADAPTOR COUPLING WITH NEOPRENE GASKET AND STAINLESS STEEL SHIELD

TUBING WITH ANSI B16.22 WROUGHT COPPER WYES AND LONG RADIUS SOLDER-JOINT FITTINGS.

D. CONDENSATE PIPING AND FITTINGS: ASTM B88 HARD DRAWN DEOXIDIZED, TYPE M COPPER

WITH TWO BANDS.

LOCATION OF WATER AND SEWER CONNECTIONS WITH BUILDING ENGINEER.

RATED CONSTRUCTION.

CAULK AIRTIGHT ALL PLUMBING PENETRATIONS IN SOUND RATED WALLS AND FLOOR/CEILINGS. SEAL

PENETRATIONS OF CONCRETE FLOORS WITH CEMENT GROUT. MINIMIZE PENETRATIONS THROUGH SOUND

3103 Independence Drive, Livermore, CA 94551

THIRD FLOOR SOUTH SAN JOSE, CA 95131

TENANT IMPROVEMENT for

DESCRIPTION **PROGRESS CD SET ISSUED FOR PERMIT** 09.29.2023 AS SHOWN 23044

PLUMBING NOTES, CODES, SCOPE OF WORK, AND

SHEET TITLE

☐ Building ☐ Electrical

☒ Plumbing ☐ Mechanical

ROBERT KHALIPA, P.E. (408) 535-7764

No. 23-114013 **Date:** 03/01/2024

P-0.1 SHEET NO.

PLUMBING EQUIPMENT SCHEDULES, CALCULATION, AND TABLES

	PLUMBING FIXTURE SCHEDULE*					
TAG	FIXTURE	MAX. WATER USAGE	DESCRIPTION			
WC (ADA)	WATER CLOSET, ADA	1.28 GPF	KOHLER KINGSTON TM TOP SPUD FLUSHOMETER BOWL. MODEL: K-4325. 1.28-GPF. ADA COMPLIANT, COMPLETE WITH 1½ TOP SPUD,IMPROVED FLUSH FOR TOILET SEAT COVER REMOVAL. COMPLETE WITH KOHLER LUSTRA K-4666-SA ELONGATED COMMERCIAL HEAVY DUTY TOILET SEAT. CONFIRM COLOR AND FINISH WITH ARCHITECT/OWNER PRIOR TO ORDER. COMPLETE WITH FACTORY WALL HUNG AND SLOAN ECOS BATTERY OPERATE SENSOR FLUSHOMETER IN POLISHED CHROME (MODEL: ECOS 8111-1.6/1.1).			
LAV (ADA)	LAVATORY, ADA	0.4 GPM	PORCELANOSA 8-BASIS CRION DESIGN BATHROOM SINK INTEGRAL AT 34" A.F.F. MAX. OVERFLOW DRAIN. ADA COMPLIANT. CONFIRM COLOR AND FINISH WITH ARCHITECT/OWNER PRIOR TO ORDER. COMPLETE WITH 2X2 STEEL ANGLE TO SUPPORT COUNTERTOP, VANDAL TRAP V8902CNC, AND SLOAN OPTIMA® BATTERY OPERATE SENSOR FAUCET IN POLISHED CHROME (MODEL: ETF-85-4-BAT-BDM-CP-0.5GPM-MLM-FCT).			
<u>UR</u> (ADA)	URINAL, ADA	0.125 GPF	KOHLER® HIGH EFFICIENCY WASHOUT URINAL. MODEL: K-4991-ET. 0.125-GPF. FLUSH VALVE, ADA COMPLIANT, COMPLETE WITH ¾" TOP SPUD INLET AND CEFIONTECT. ANTIMICROBIAL FINISH. COMPLETE WITH FACTORY WALL CARRIER AND SLOAN ECOS® BATTERY OPERATE SENSOR FLUSHOMETER (MODEL: ECOS 8186-0.125). CONFIRM COLOR AND FINISH WITH ARCHITECT/OWNER PRIOR TO ORDER.			
<u>TP</u>	TRAP PRIMER		PRECISION PLUMBING PRODUCTS (PPP) MODEL MP-500-12V TRAP PRIMER WITH BATTERY OPERATED SOLENOID VALVE AND KEY OPERATED LOCKABLE RECESSED WALL BOX. PROVIDE DISTRIBUTION UNIT FOR VALVE SERVING MORE THAN 1 FLOOR DRAIN.			
DF (ADA)	DRINKING FOUNTAIN, ADA	N/A	ELKAY, MODEL: EZH20® BOTTLE FILLING STATION & SINGLE ADA COOLER REFRIGERATED STATINLESS HIGH CAPACITY LEAD REDUCTION QUICK FILTER CHANGE, MODEL LZS8WSSP.			
<u>HB</u>	HOSE BIBB	1.5 GPM	CHICAGO FAUCETS MODEL 387-E27CP MANUAL FAUCETS HOSE BIBB. INSIDE SILL FITTING. POLISHED CHROME PLATED FINISH. 2½" TEE HANDLE. SLOW COMPRESSION RENEWABLE CARTRIDGE THAT CLOSES WITH WATER PRESSURE WITH TAPERED SQUARE BROACH TO FACILITATE HANDLE REMOVAL, CATALOG#217-XTLH. IN-LINE VACUUM BREAKER HOSE THREAD OUTLET, CATALOG #27. ¾"NPT FEMALE INLET. ¾" MAL GARDEN HOSE THREAD OUTLET. LOOSE WALL FLANGE. RATED OPERATING PRESSURE: 20-125 PSI. RATED OPERATING TEMPERATURE: 40-140°F.			
WCO	WALL CLEAN-OUT		ZURN Z1446 WALL CLEAN-OUT W/ ROUND WALL ACCESS COVER CLEANOUT TEE, DURA-COATED CAST IRON BODY, GAS AND WATERTIGHT ABS TAPERED PLUG, AND ROUND, SMOOTH STAINLESS STEEL WALL ACCESS COVER WITH SECURING SCREW. D.C.C.I.WITH POLISHES STAINLESS STEEL COVER.			
<u>FCO</u>	FLOOR CLEAN-OUT		ZURN/Z1400 EXTRA-HEAVY-DUTY "LEVEL-TROL" ADJUSTABLE FLOOR CLEAN-OUT. DURA-COATED CAST IRON BODY WITH GAS AND WATERTIGHT ABS TAPERED PLUG, AND SECURED TOP. 4" INSIDE CAULK.			

ALL PLUMBING FIXTURES AND FITTING SHALL MEET THE STANDARDS REFERENCED IN TABLE 604.1 AND TABLE 701.2 OF 2018 UNIFORM PLUMBING CODE.

	PLUMBING EQUIPMENT SCHEDULE
TAG	DESCRIPTION
(E) EWH 01	EXISTING A.O.SMITH: DEL-20-A. WATER HEATER, NOMINAL GALLON CAPACITY 20 GAL. PROVIDE NEW FACTORY LISTED FLEXIBLE HOSE CONNECTION, UNION FITTINGS, ISOLATION VALVES, CHECK VALVE, AND AMTROL ST-5-C EXPANSION TANK. PROVIDE INSPECTION AND FUNCTIONAL TEST TO EXISTING WATER HEATER. REPLACE WATER HEATER WITH MATCH SPEC AS NEEDED.

BELL AND GOSSETT LEAD FREE (CA AB1953 COMPLIANT) RECIRCULATOR MODEL: NBF-25, 3-SPEED, 3/4 MAX. 125WATTS. COMPLETE WITH LEAD FREE BODY, FACTORY ADJUSTABLE AQUASTAT AND TIMER MODULE FOR PUMP CONTROL. COORDINATE WITH ELECTRICAL CONTRACTOR FOR PROVISION OF 115/1PH POWER, DISCONNECT, AND WIRING BY ELECTRICAL CONTRACTOR.

PLUMBING MATERIAL SCHEDULE*					
ITEM	LOCATION	SPECIFICATIONS			
DOMESTIC COLD WATER PIPE	ABOVE GRADE	TYPE L COPPER. PIPE SHALL CONFORM WITH ASTM-(B42, B43, B75, B88, B135, B251, B302, B447). PIPE FITTING SHALL CONFORM WITH ASTM-(B16.15, B16.18, B16.22, B16.26, B16.50, B16.51), ASSE 1061.			
DOMESTIC COLD WATER PIPE	BELOW GRADE	TYPE K COPPER. PIPE SHALL CONFORM WITH ASTM-(B42, B43, B75, B88, B135, B251, B302, B447). PIPE FITTING SHALL CONFORM WITH ASTM-(B16.15, B16.18, B16.22, B16.26, B16.50, B16.51), ASSE 1061.			
SANITARY WASTE AND VENT PIPE	ABOVE GRADE	CAST IRON NO-HUB. PIPE SHALL CONFORM WITH ASTM-D2661, ASTM D2680. PIPE FITTING SHALL CONFORM WITH ASTM D2661, ASTM D2680			
SANITARY WASTE AND VENT PIPE	BELOW GRADE	CAST IRON NO-HUB. PIPE SHALL CONFORM WITH ASTM-D2661, ASTM D2680. PIPE FITTING SHALL CONFORM WITH ASTM D2661, ASTM D2680			

- SCHEDULE SHOWN FOR QUICK REFERENCE ONLY. SEE COMPLETE MATERIAL SPECIFICATIONS ON P-0.1.
- MATERIALS FOR DRAINAGE PIPING SHALL BE IN ACCORDANCE WITH ONE OF THE REFERENCED STANDARDS IN TABLE 701.2. MATERIALS FOR BUILDING WATER PIPING AND BUILDING SUPPLY PIPING SHALL COMPLY WITH THE APPLICABLE STANDARD REFERENCED IN TABLE 604.1.
- ALL METALLIC NATURAL GAS PIPE AND JOINTING SHALL COMPLY WITH STANDARDS LISTED UNDER UPC 1208.6.

	FIXTURE		WATER			SANITARY WASTE		
TAG	TYPE	QTY	EACH	TOTAL	QTY	EACH	TOTAL	
WC	WATER CLOSET	6		125.0	6	4.0	24.0	
LAV	LAVATORY	6	1.0	6.0	6	1.0	6.0	
<u>UR</u>	URINAL	1		20	1	4.0	4.0	
(E)FD	FLOOR DRAIN	3	N/A		3	2.0	6.0	
<u>TP</u>	TRAP PRIMER	1	1.0	1.0		N/A		
(E)MS	MOP SINK	1	3.0	3.0	1	3.0	3.0	
(E)DF	DRINK FOURTAIN	1	1.0	1.0	1	1.0	1.0	
<u>DF</u>	DRINK FOURTAIN	1	1.0	1.0	1	1.0	1.0	
<u>HB</u>	HOSE BIBB	2	1.0	2.0		N/A		
	TOTAL FU		159			45		

MAKE CONNECTION TO DEDICATED WATER FILTER THEN TO FIXTURE.

WATER SUPPLY SYSTEM: (PER 2022 CPC TABLE 610.4, 46~60 PSI)

DISTANCE TO MOST REMOTE FIXTURE = 200 FT. MIN. REQUIRED SIZE OF WATER MAIN: 2"Ø MAIN EXISTING COLD WATER MAIN: (E) 2"Ø MAIN

WASTE AND VENT SYSTEM: (PER 2022 CPC TABLE 703.2)

MINIMUM REQUIRED SIZE OF WASTE MAIN: (1) 4"Ø SW EXISTING BUILDING WASTE MAIN: (1) 4"Ø SW PROVIDED PLUMBING WASTE MAIN: (1)4"Ø SW MINIMUM REQUIRED SIZE OF VENT PIPE: (1) 3"Ø V. PROVIDED PLUMBING VENT: (1) 3"Ø V

	MINIMUM P	LUMBING	FIXTURE E	BRANCH PI	PE SIZE*		
TAG	FIXTURE	WASTE	TRAP	VENT	CW	HW	REMARI
<u>WC</u>	WATER CLOSET (FLUSH VALVE)	3"Ø		2"Ø	1½"Ø		1
<u>UR</u>	URINAL (FLUSH VALVE)	2"Ø	1½"Ø	2"Ø	1½"Ø		1
<u>LAV</u>	LAVATORY	2"Ø	1½"Ø	1½"Ø	½"Ø	½"Ø	12
(E)MS	MOP SINK	2"Ø	2"Ø	2"Ø	3⁄4"Ø	3/ ₄ "Ø	13
<u>DF</u>	DRINKING FOUNTAIN	2"Ø		1½"Ø	3⁄4"Ø		1
<u>TP</u>	TRAP PRIMER				½"Ø		1
<u>HB</u>	HOSE BIBB				½"Ø		1

- PIPE SIZES SHOWN ARE NOT FIXTURE CONNECTION SIZE BUT BRANCH LINE SIZE. SEE FINAL PRODUCT MANUFACTURER RECOMMENDED PIPING CONNECTION SIZES PRIOR TO INSTALL. PROVIDE REDUCER BETWEEN BRANCH LINE AND CONNECTION AS REQUIRED.
- ** UNDERGROUND VENT PIPE AND TRAP ARM EXTENSION SHALL COMPLY WITH UPC TABLE REMARKS
- (1) PROVIDE WATER HAMMER ARRESTER (ZURN/1250XL)FOR EACH FIXTURE BANK
- AND MIN. 18" AIR CHAMBER AT EACH PLUMBING FIXTURE.
- 2 PROVIDE THERMAL MIXING VALVE AND SET HOT WATER TEMPERATURE NO HIGHER THAN 110°F. ③ PROVIDE BACKFLOW PREVENTION DEVICE AT EQUIPMENT CONNECTION

JEP Engin	eering and


Design services inc. ADD: 3103 Independence Drive, Livermore, CA 94551 510-468-0613

PROJECT ADDRESS

CEL: 925-409-2508

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TENANT IMPROVEMENT for SANTA CLARA COUNTY OFFICE OF EDUCATION

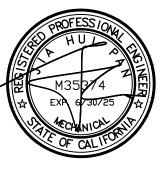


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DATE	DESCRIPTION
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JURISDICTION APPROVAL STAMP

PLUMBING SCHEDULES, CALCULATIONS, AND **TABLES**

SHEET TITLE

Reviewed for Code Compliance

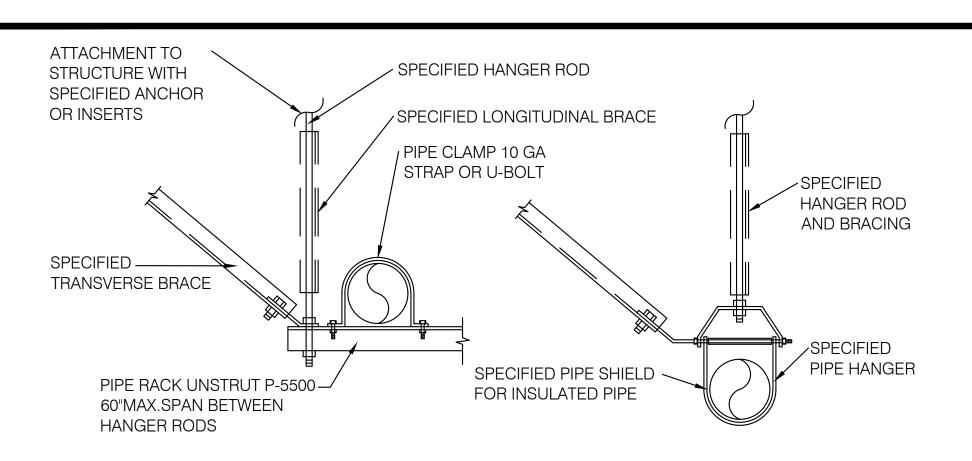


PIPE SIZE	HANGER ROD	MAX. WEIGHT PER HANGER LOAD	MAXIMUM PIPE SUPPORT SPACING			
FIFE SIZE	SIZE		COPPER TUBE OR PIPE	STEEL PIPE	CAST-IRON	
1/2"-11/2"	3/8"	610 LBS	6'-0"	6'-0"	EVERY OTHER JOINT,	
2'-3"	1/2"	730 LBS	10'-0"	10'-0"	UNLESS OVER 4' THEN	
>= 4"	5/8"	810 LBS	10'-0"	10'-0"	SUPPORT EACH JOINT	

NOTES:

- 1. SUPPORT PIPES AT INTERVALS INDICATED AND AT EACH CHANGE OF DIRECTION.
- 2. MULTIPLE PIPES MAY BE SUPPORTED ON A COMMON TRAPEZE SIZE AND SPACING TRAPEZE SIZE AND SUPPORT SPACING SHALL BE GOVERNED BY CUMULATIVE WEIGHT OF SUPPORTED PIPING.
- 3. BRACE PIPING LONGITUDINALLY AND TRANSVERSELY ACCORDING TO SMACNA GUIDELINES FOR SEISMIC
- RESTRAINTS OF MECHANICAL SYSTEM AND PLUMBING PIPING SYSTEM

 4. ALL PIPE HANGER AND SUPPORT SHALL CONFORM TO 2018 UMC TABLE 313.6 AND 313.1



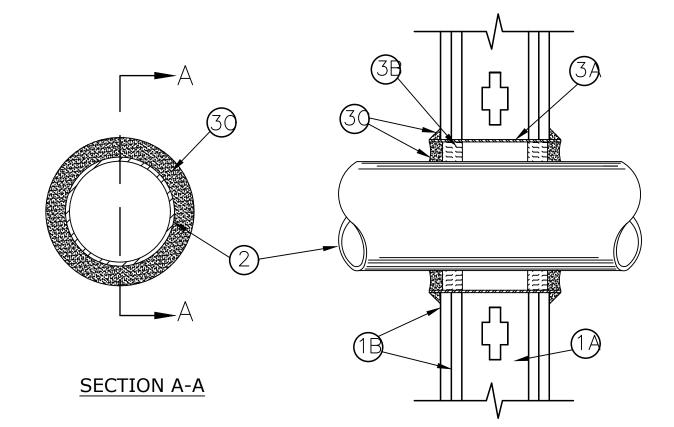

SYSTEM NO.W-L-1003 SEPTEMBER 03, 2004 (FORMERLY SYSTEM NO. 147) F RATINGS - 1 AND 2 HR (SEE ITEM 1) - T RATING - 0 HR


- 1. WALL ASSEMBLY THE 1 OR 2 HR FIRE-RATED GYPSUM WALLBOARD/STUD WALL ASSEMBLY SHALL BE CONSTRUCTED OF THE MATERIALS AND IN THE MANNER DESCRIBED IN THE INDIVIDUAL U300 OR U400 SERIES WALL OR PARTITION DESIGN IN THE UL FIRE RESISTANCE DIRECTORY AND SHALL INCLUDE THE FOLLOWING CONSTRUCTION FEATURES:
- A. STUDS WALL FRAMING MAY CONSIST OF EITHER WOOD STUDS OR STEEL CHANNEL STUDS. WOOD STUDS TO CONSIST OF NOM 2 BY 4 IN. LUMBER SPACED 16 IN. OC WITH NOM 2 BY 4 IN. LUMBER END PLATES AND CROSS BRACES. STEEL STUDS TO BE MIN 3-1/2 IN. WIDE BY 1-3/8 IN. DEEP CHANNELS SPACED MAX 24 IN. OC.
- B. GYPSUM BOARD* NOM 5/8 IN. THICK, 4 FT. WIDE WITH SQUARE OR TAPERED EDGES. THE GYPSUM WALLBOARD TYPE,
 THICKNESS, NUMBER OF LAYERS, FASTENER TYPE AND SHEET ORIENTATION SHALL BE AS SPECIFIED IN THE INDIVIDUAL
 LISON OR LIAON SERIES DESIGN IN THE UIL FIRE RESISTANCE DIRECTORY, MAY DIAMETER OF OPENING IS 15 IN
- U300 OR U400 SERIES DESIGN IN THE UL FIRE RESISTANCE DIRECTORY. MAX DIAMETER OF OPENING IS 15 IN.
 THE HOURLY F RATING OF THE FIRESTOP SYSTEM IS EQUAL TO THE HOURLY FIRE RATING OF THE WALL ASSEMBLY IN WHICH IT IS INSTALLED.
- 2. THROUGH PENETRANT ONE METALLIC PIPE, CONDUIT OR TUBING TO BE INSTALLED EITHER CONCENTRICALLY OR ECCENTRICALLY WITHIN THE FIRESTOP SYSTEM. THE SPACE BETWEEN PIPES, CONDUITS OR TUBING AND THE STEEL SLEEVE (ITEM 3A) SHALL BE MIN OF 0 IN. (POINT CONTACT) TO MAX 2-3/8 IN. PIPE, CONDUIT OR TUBING TO BE RIGIDLY SUPPORTED ON BOTH SIDES OF WALL ASSEMBLY. THE FOLLOWING TYPES AND SIZES OF METALLIC PIPES, CONDUITS OR TUBING MAY BE USED:
- A. STEEL PIPE NOM 12 IN. DIAM (OR SMALLER) SCHEDULE 10 (OR HEAVIER) STEEL PIPE.
- B. IRON PIPE NOM 12 IN. DIAM (OR SMALLER) SERVICE WEIGHT (OR HEAVIER) CAST IRON SOIL PIPE, NOM 12 IN. DIAM (OR SMALLER) OR CLASS 50 (OR HEAVIER) DUCTILE IRON PRESSURE PIPE.
- C. CONDUIT NOM 6 IN. DIAM (OR SMALLER) STEEL CONDUIT OR NOM 4 IN. DIAM (OR SMALLER) STEEL ELECTRICAL METALLIC
- D. COPPER TUBING NOM 6 IN. DIAM (OR SMALLER) TYPE L (OR HEAVIER) COPPER TUBING.
- E. COPPER PIPE NOM 6 IN. DIAM (OR SMALLER) REGULAR (OR HEAVIER) COPPER PIPE.
- 3. FIRESTOP SYSTEM INSTALLED SYMMETRICALLY ON BOTH SIDES OF WALL ASSEMBLY. THE DETAILS OF THE FIRESTOP SYSTEM SHALL BE AS FOLLOWS.
- A. STEEL SLEEVE CYLINDRICAL SLEEVE FABRICATED FROM MIN 0.019 IN. THICK (NO. 28 GAUGE) GALV SHEET STEEL AND HAVING A MIN 2 IN. LAP ALONG THE LONGITUDINAL SEAM. LENGTH OF STEEL SLEEVE TO BE EQUAL TO THICKNESS OF WALL PLUS 1 TO 4 IN. SUCH THAT, WHEN INSTALLED, THE ENDS OF THE SLEEVE WILL PROJECT APPROXIMATELY 1/2 TO 2 IN. BEYOND THE SURFACE OF THE WALL ON BOTH SIDES OF THE WALL ASSEMBLY. SLEEVE INSTALLED BY COILING THE SHEET STEEL TO A DIAM SMALLER THAN THE THROUGH OPENING, INSERTING THE COIL THROUGH THE OPENINGS AND RELEASING THE COIL TO LET IT UNCOIL AGAINST THE CIRCULAR CUTOUTS IN THE GYPSUM WALLBOARD LAYERS.
- B. PACKING MATERIAL MIN 1 IN. THICKNESS OF MINERAL WOOL BATT INSULATION FIRMLY PACKED INTO STEEL SLEEVE ON BOTH SIDES OF THE WALL ASSEMBLY AS PERMANENT FORMS. PACKING MATERIAL TO BE RECESSED MIN 1/2 IN. FROM END OF STEEL SLEEVE (FLUSH WITH OR RECESSED INTO GYPSUM WALLBOARD SURFACE) ON BOTH SIDES OF WALL ASSEMBLY.

B1. PACKING MATERIAL - (NOT SHOWN) - AS AN ALTERNATE TO ITEM B, NOM 1 IN. THICK POLYETHYLENE BACKER ROD MAY BE USED. THE BACKER ROD IS TO BE RECESSED WITHIN THE STEEL SLEEVE A MIN OF 1 IN. FROM EACH SURFACE OF WALL. C. FILL, VOID OR CAVITY MATERIALS* - CAULK OR SEALANT - WHEN MINERAL WOOL BATT INSULATION IS USED, APPLIED TO FILL THE STEEL SLEEVE TO A MIN DEPTH OF 1/2 IN. ON BOTH SIDES OF WALL ASSEMBLY. WHEN BACKER ROD IS USED, A MIN THICKNESS OF 1 IN. OF CP-25WB+ CAULK IS REQUIRED FLUSH WITH SURFACE OF WALL. A NOM 1/4 IN. DIAM CONTINUOUS BEAD OF CAULK OR SEALANT SHALL BE APPLIED AROUND THE CIRCUMFERENCE OF THE STEEL SLEEVE AT ITS EGRESS FROM THE GYPSUM WALLBOARD LAYERS ON BOTH SIDES OF THE WALL ASSEMBLY.


3M COMPANY - CP 25WB+ CAULK OR FB-3000 WT SEALANT.

*BEARING THE UL CLASSIFICATION MARKING



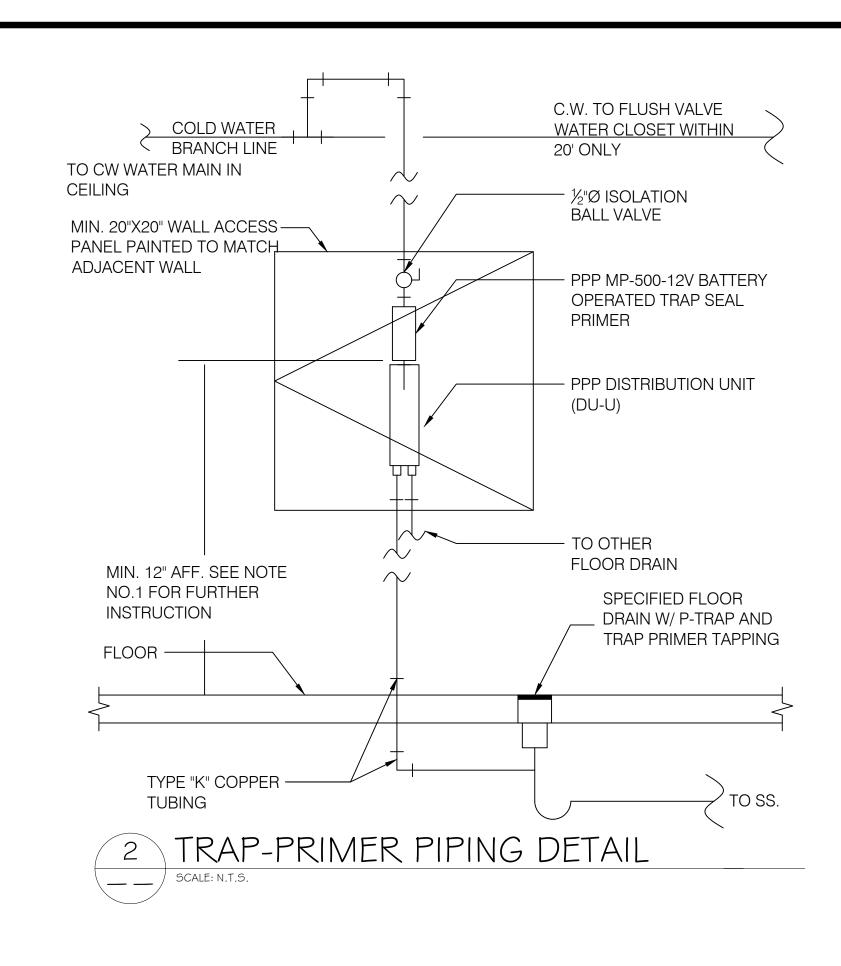

NOT USE

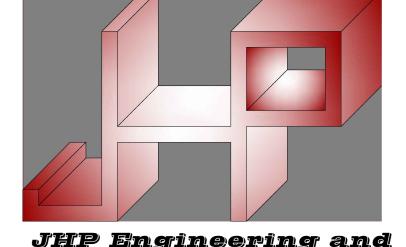

JHP Engineering and Design Services Inc.

ADD: 3103 Independence Drive, Livermore, CA 94551
TEL: 510-468-0613

925-409-2508

PROJECT ADDRESS

CEL:

1290 RIDDER PARK DR, THIRD FLOOR SOUTH SAN JOSE, CA 95131

TENANT IMPROVEMENT for

SANTA CLARA COUNTY OFFICE OF EDUCATION



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PLUMBING DETAILS

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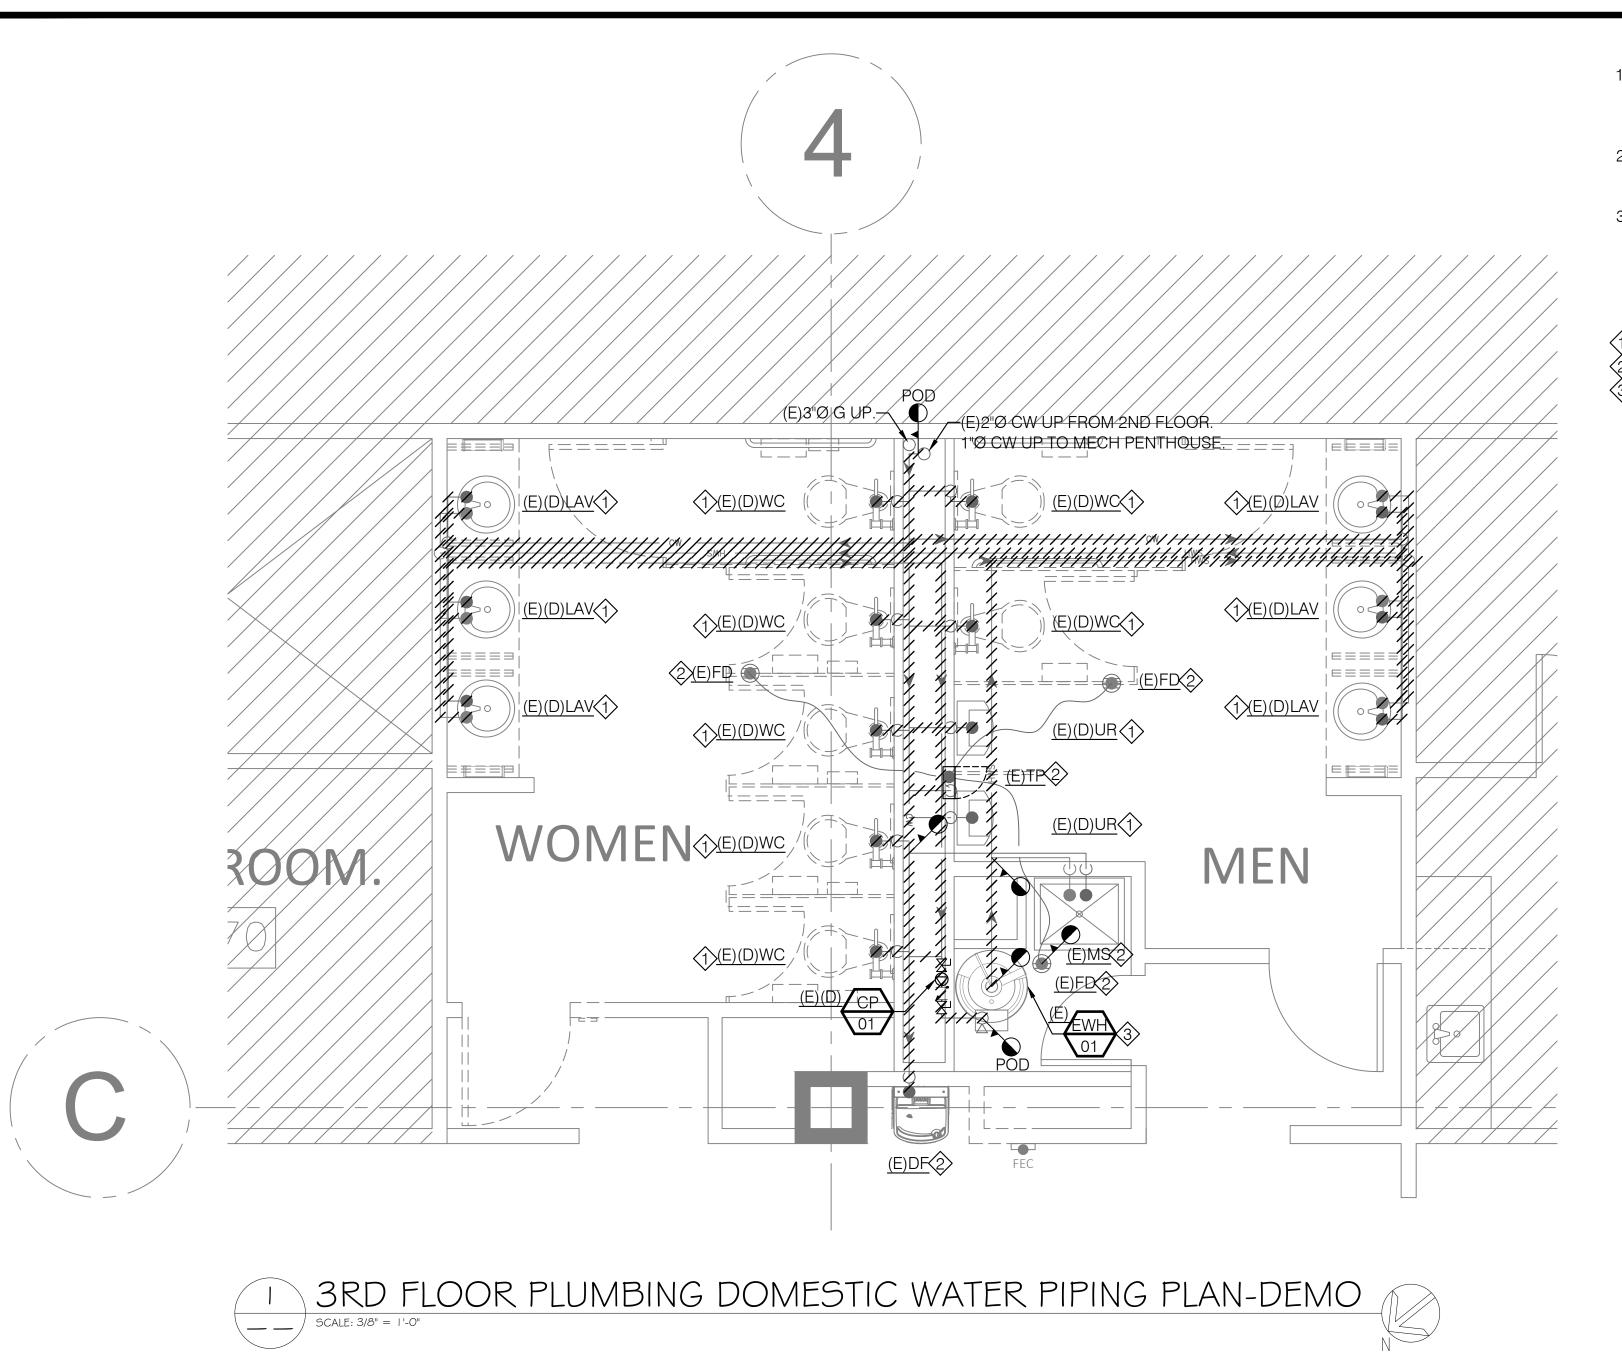
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City of San Jose, Building Division

☐ Building ☐ Electrical
☐ Plumbing ☐ Mechanical

ROBERT KHALIPA, P.E. (408) 535-7764
No. 23-114013 ☐ Date: 03/01/2024

SHEET NO. P-0.3



GENERAL NOTES:

- EXISTING PIPE SIZES AND LOCATIONS SHOWN ON PLAN ARE FOR REFERENCE ONLY. CONTRACTOR SHALL INVESTIGATE AND VERIFY EXACT PIPE SIZE, ROUTE, INVERT, AND CONDITION OF ALL EXISTING PLUMBING UTILITIES PRIOR TO BID AND CONSTRUCT.
- 2. PLUMBING/GENERAL CONTRACTOR TO COORDINATE WITH LANDLORD FOR SCHEDULES OF CONSTRUCTION THAT ARE OUTSIDE OF THE TENANT SPACE.
- 3. PLUMBING CONTRACTOR IS RESPONSIBLE TO VERIFY EXACT LOCATION, SIZE, INVERT, AND CONDITION OF EXISTING PIPE ROUTE AND CONFIRM THE CONSTRUCT ABILITY OF PROPOSED SYSTEM PRIOR TO CONSTRUCT. REPORT TO ENGINEER / ARCHITECT FOR ANY DISCREPANCY OBSERVED

SHEET NOTES:

- DEMOLISH AND REMOVE (E)PLUMBING FIXTURES. CUT AND CAP CONNECTION BACK TO POD PER PLAN. TYPICAL.
- (E)PLUMBING FIXTURE TO REMAIN AND REUSE. TYPICAL.
- (E)WATER HEATER TO BE REMAIN AND REUSE.

JHP Engineering and Design Services Inc.

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PROJECT ADDRESS

925-409-2508

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3RD FLOOR PLUMBING PLAN-DEMO

SHEET TITLE

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P-1.0 SHEET NO.


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DEMOLISH AND REMOVE (E)PLUMBING FIXTURES. CUT AND CAP CONNECTION BACK TO POC PER PLAN. TYPICAL.


(E)PLUMBING FIXTURE TO REMAIN AND REUSE.




2 3RD FLOOR PLUMBING WASTE AND VENT PIPING PLAN-DEMO

SCALE: 3/8" = |'-0"

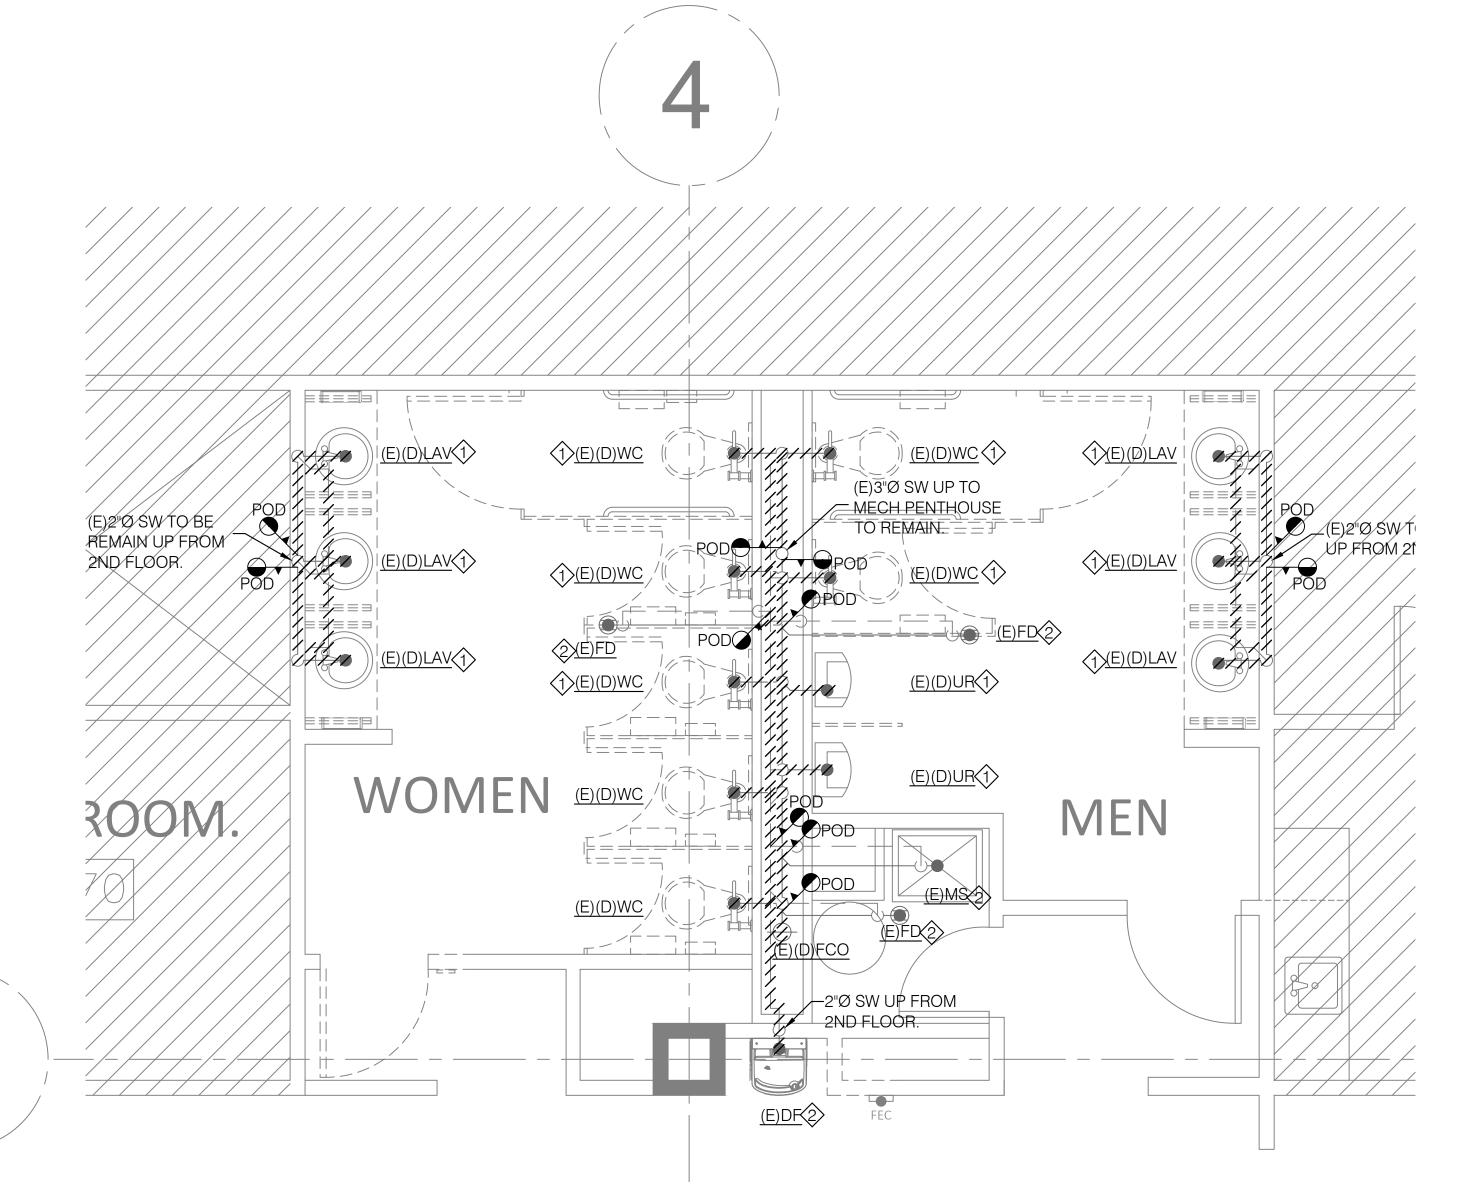Reviewed for Code Compliance
City of San Jose, Building Division ☐ Building ☐ Electrical ☑ Plumbing ☐ Mechanical ROBERT KHALIPA, P.E. (408) 535-7764 No. 23-114013 Date: 03/01/2024

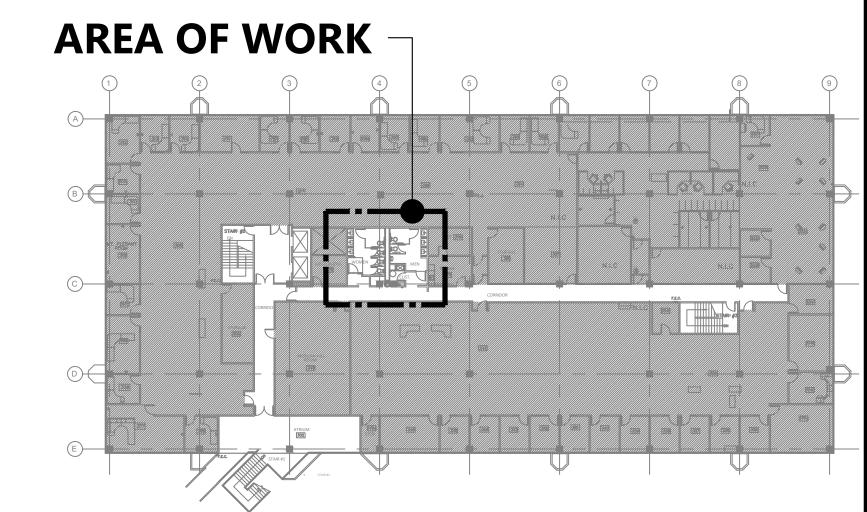

SCALE: N.T.S.

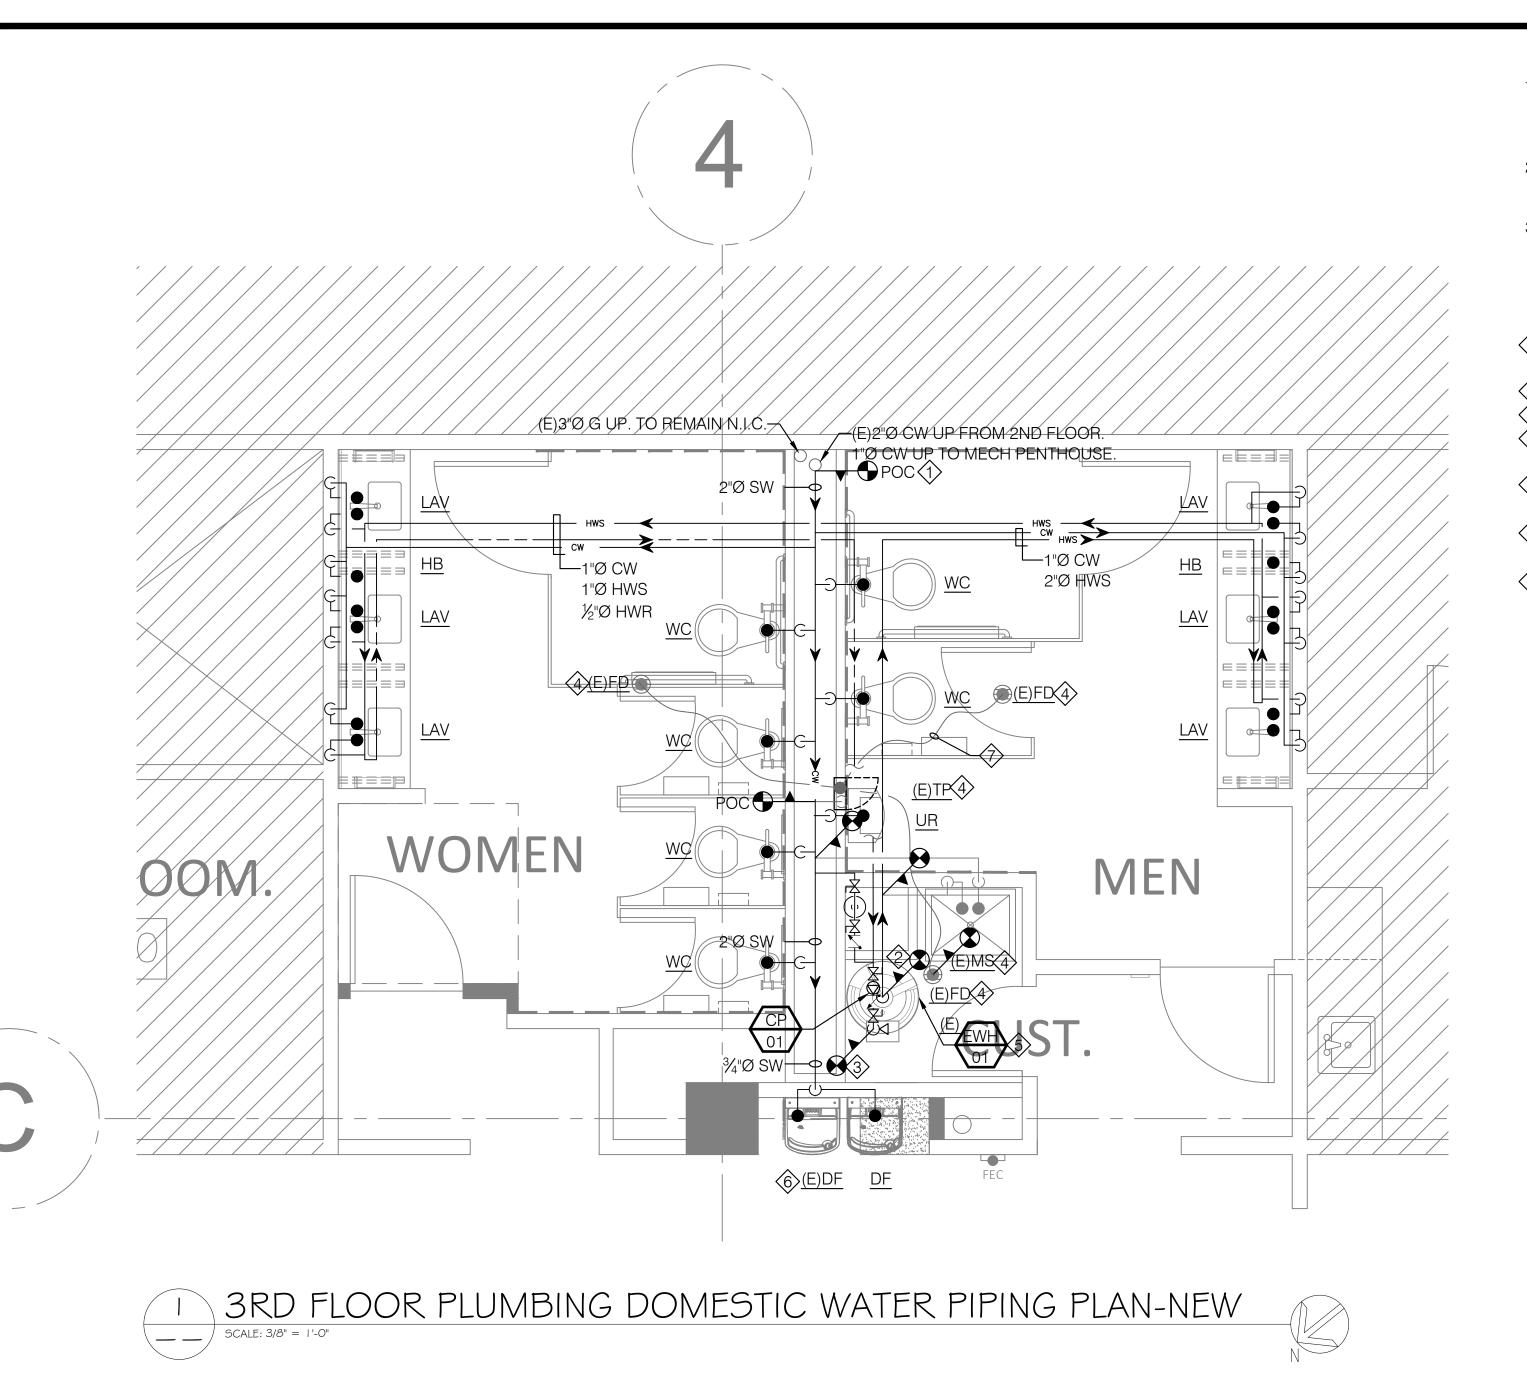

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SHEET NOTES:

- CONNECT (N)2"Ø CW TO (E)2"Ø CW MAIN. CONTRACTOR TO CONFIRM EXACT LOCATION, SIZE AND CONDITION PRIOR TO CONSTRUCTION.
- ② CONNECT (N)2"Ø HWS TO (E)WATER HEATER WITH NEW FITTING AND VALVES.
- CONNECT (N)½"Ø HWR TO (E)WATER HEATER.
- > (E)PLUMBING FIXTURE TO REMAIN. CONTRACTOR TO RECONNECT EXISTING FIXTURE FOR SERVICEABILITY IF SYSTEM IS ALTERED. VERIFY EXACT PIPE ROUTE AT FIELD.
- (E)WATER HEATER TO REMAIN. CONTRACTOR TO VERIFY EXISTING CONDITION AND PROVIDE NEW PIPING COMPONENTS PER PLAN TO COMPLY WITH LATEST PLUMBING CODE.
- (E) DRINKING FOUNTAIN TO REMAIN. CONTRACTOR TO VERIFY EXISTING CONDITION AND PROVIDE NEW PIPING COMPONENTS PER PLAN TO COMPLY WITH LATEST PLUMBING CODE.
- PROVIDE CONNECTION BETWEEN (N) TRAP PRIMER TO (E) FLOOR DRAIN AS REQUIRED. V.I.F. TYPICAL.



925-409-2508 CEL:

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3RD FLOOR PLUMBING PLAN-NEW

SHEET TITLE


P-2.0 SHEET NO.

GENERAL NOTES:

- EXISTING PIPE SIZES AND LOCATIONS SHOWN ON PLAN ARE FOR REFERENCE ONLY. CONTRACTOR SHALL INVESTIGATE AND VERIFY EXACT PIPE SIZE, ROUTE, INVERT, AND CONDITION OF ALL EXISTING PLUMBING UTILITIES PRIOR TO BID AND CONSTRUCT.
- PLUMBING/GENERAL CONTRACTOR TO COORDINATE WITH LANDLORD FOR SCHEDULES OF CONSTRUCTION THAT ARE OUTSIDE OF THE TENANT SPACE.
- PLUMBING CONTRACTOR IS RESPONSIBLE TO VERIFY EXACT LOCATION, SIZE, INVERT, AND CONDITION OF EXISTING PIPE ROUTE AND CONFIRM THE CONSTRUCT ABILITY OF PROPOSED SYSTEM PRIOR TO CONSTRUCT. REPORT TO ENGINEER / ARCHITECT FOR ANY DISCREPANCY OBSERVED


SHEET NOTES:

- (1) (N)4"Ø SW MAIN HEADER RECONNECT TO (E)4"Ø SW RISER DOWN TO FLOOR BELOW. CONTRACTOR TO VERIFY EXACT LOCATION, SIZE, AND CONDITION OF RISER PRIOR TO CONSTRUCT.
- $\langle \rangle$ (N)2"Ø SW MAIN HEADER RECONNECT TO (E)2"Ø SW RISER DOWN TO FLOOR BELOW.CONTRACTOR TO VERIFY EXACT LOCATION, SIZE, AND CONDITION OF RISER PRIOR TO CONSTRUCT. TYPICAL.
- (E)PLUMBING FIXTURE TO REMAIN. CONTRACTOR TO RECONNECT EXISTING FIXTURE FOR SERVICEABILITY IF SYSTEM IS
- ALTERED. VERIFY EXACT PIPE ROUTE AT FIELD. (E)SW SERVING (E)FLOOR DRAIN TO REMAIN.

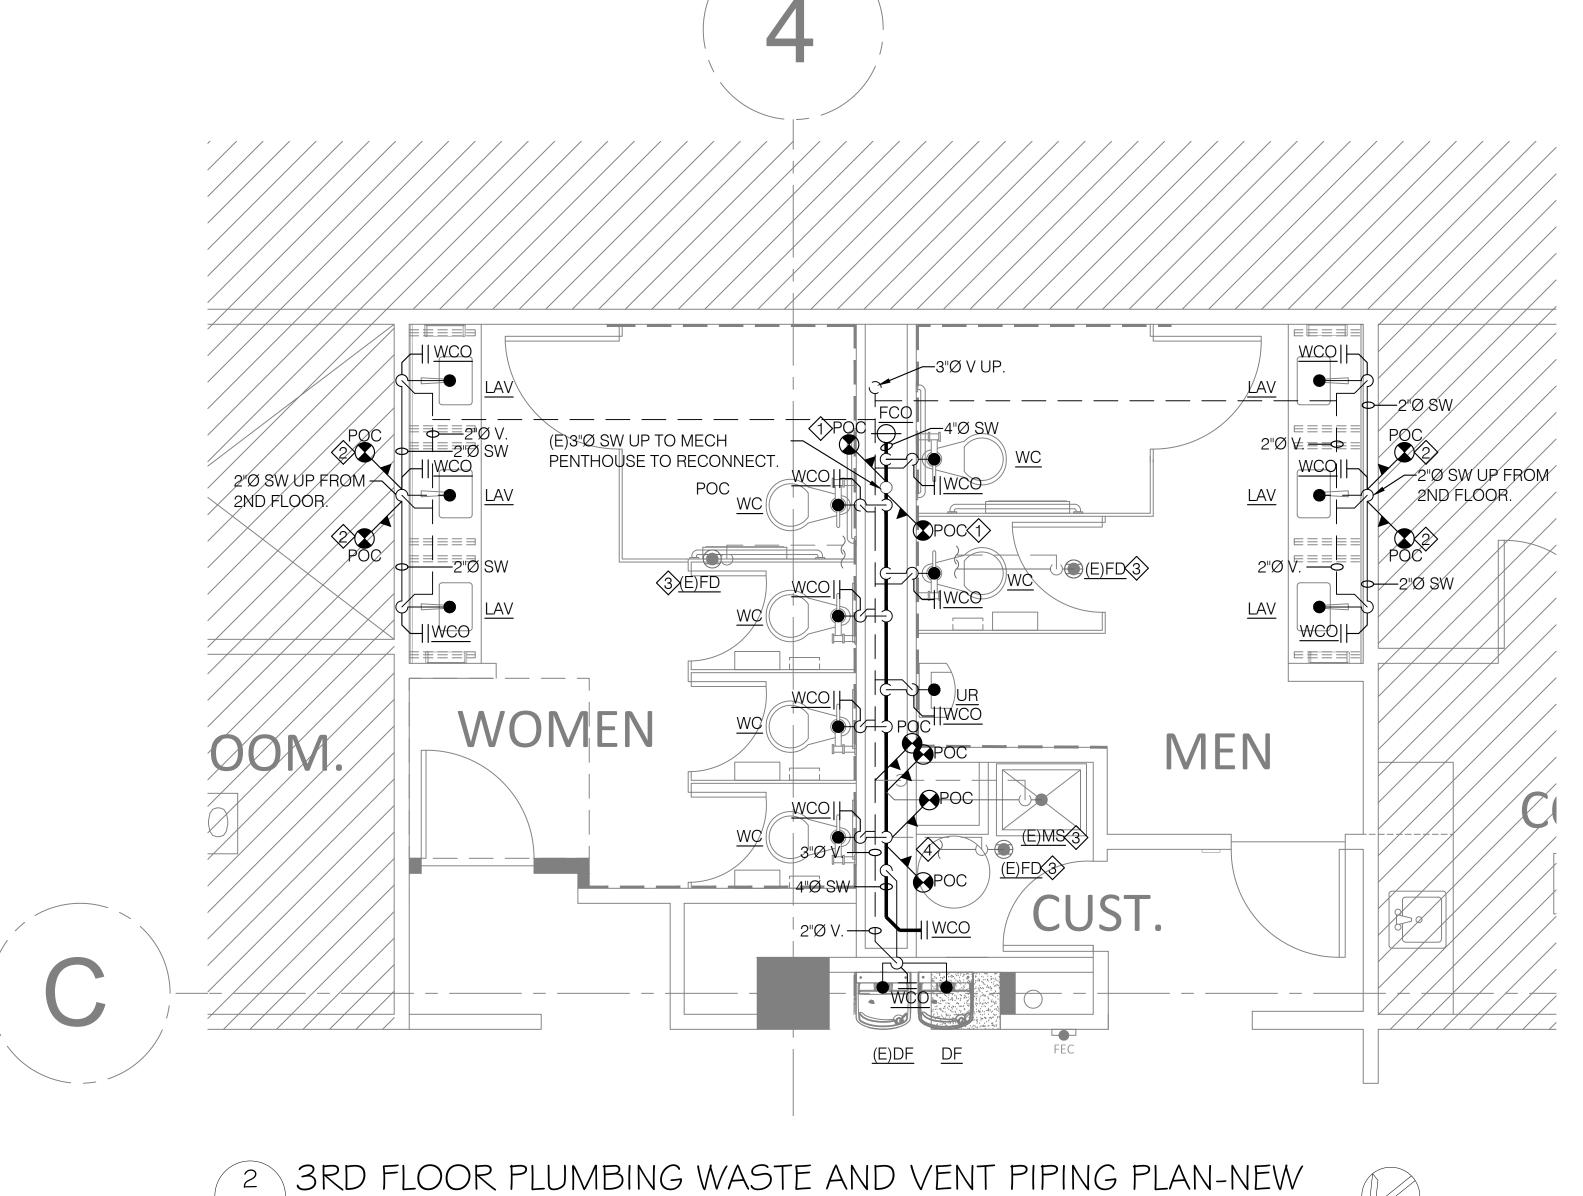

SCALE: 3/8" = 1'-0"

Reviewed for Code Compliance City of San Jose, Building Division ☐ Building ☐ Electrical **☒** Plumbing ☐ Mechanical **ROBERT KHALIPA, P.E. (408) 535-7764** No. 23-114013 Date: 03/01/2024

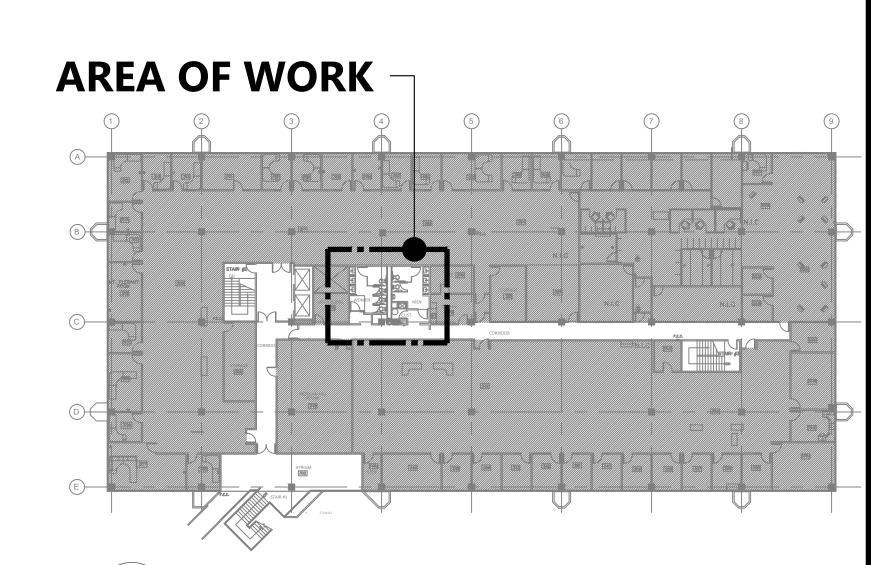

SCALE: N.T.S.